

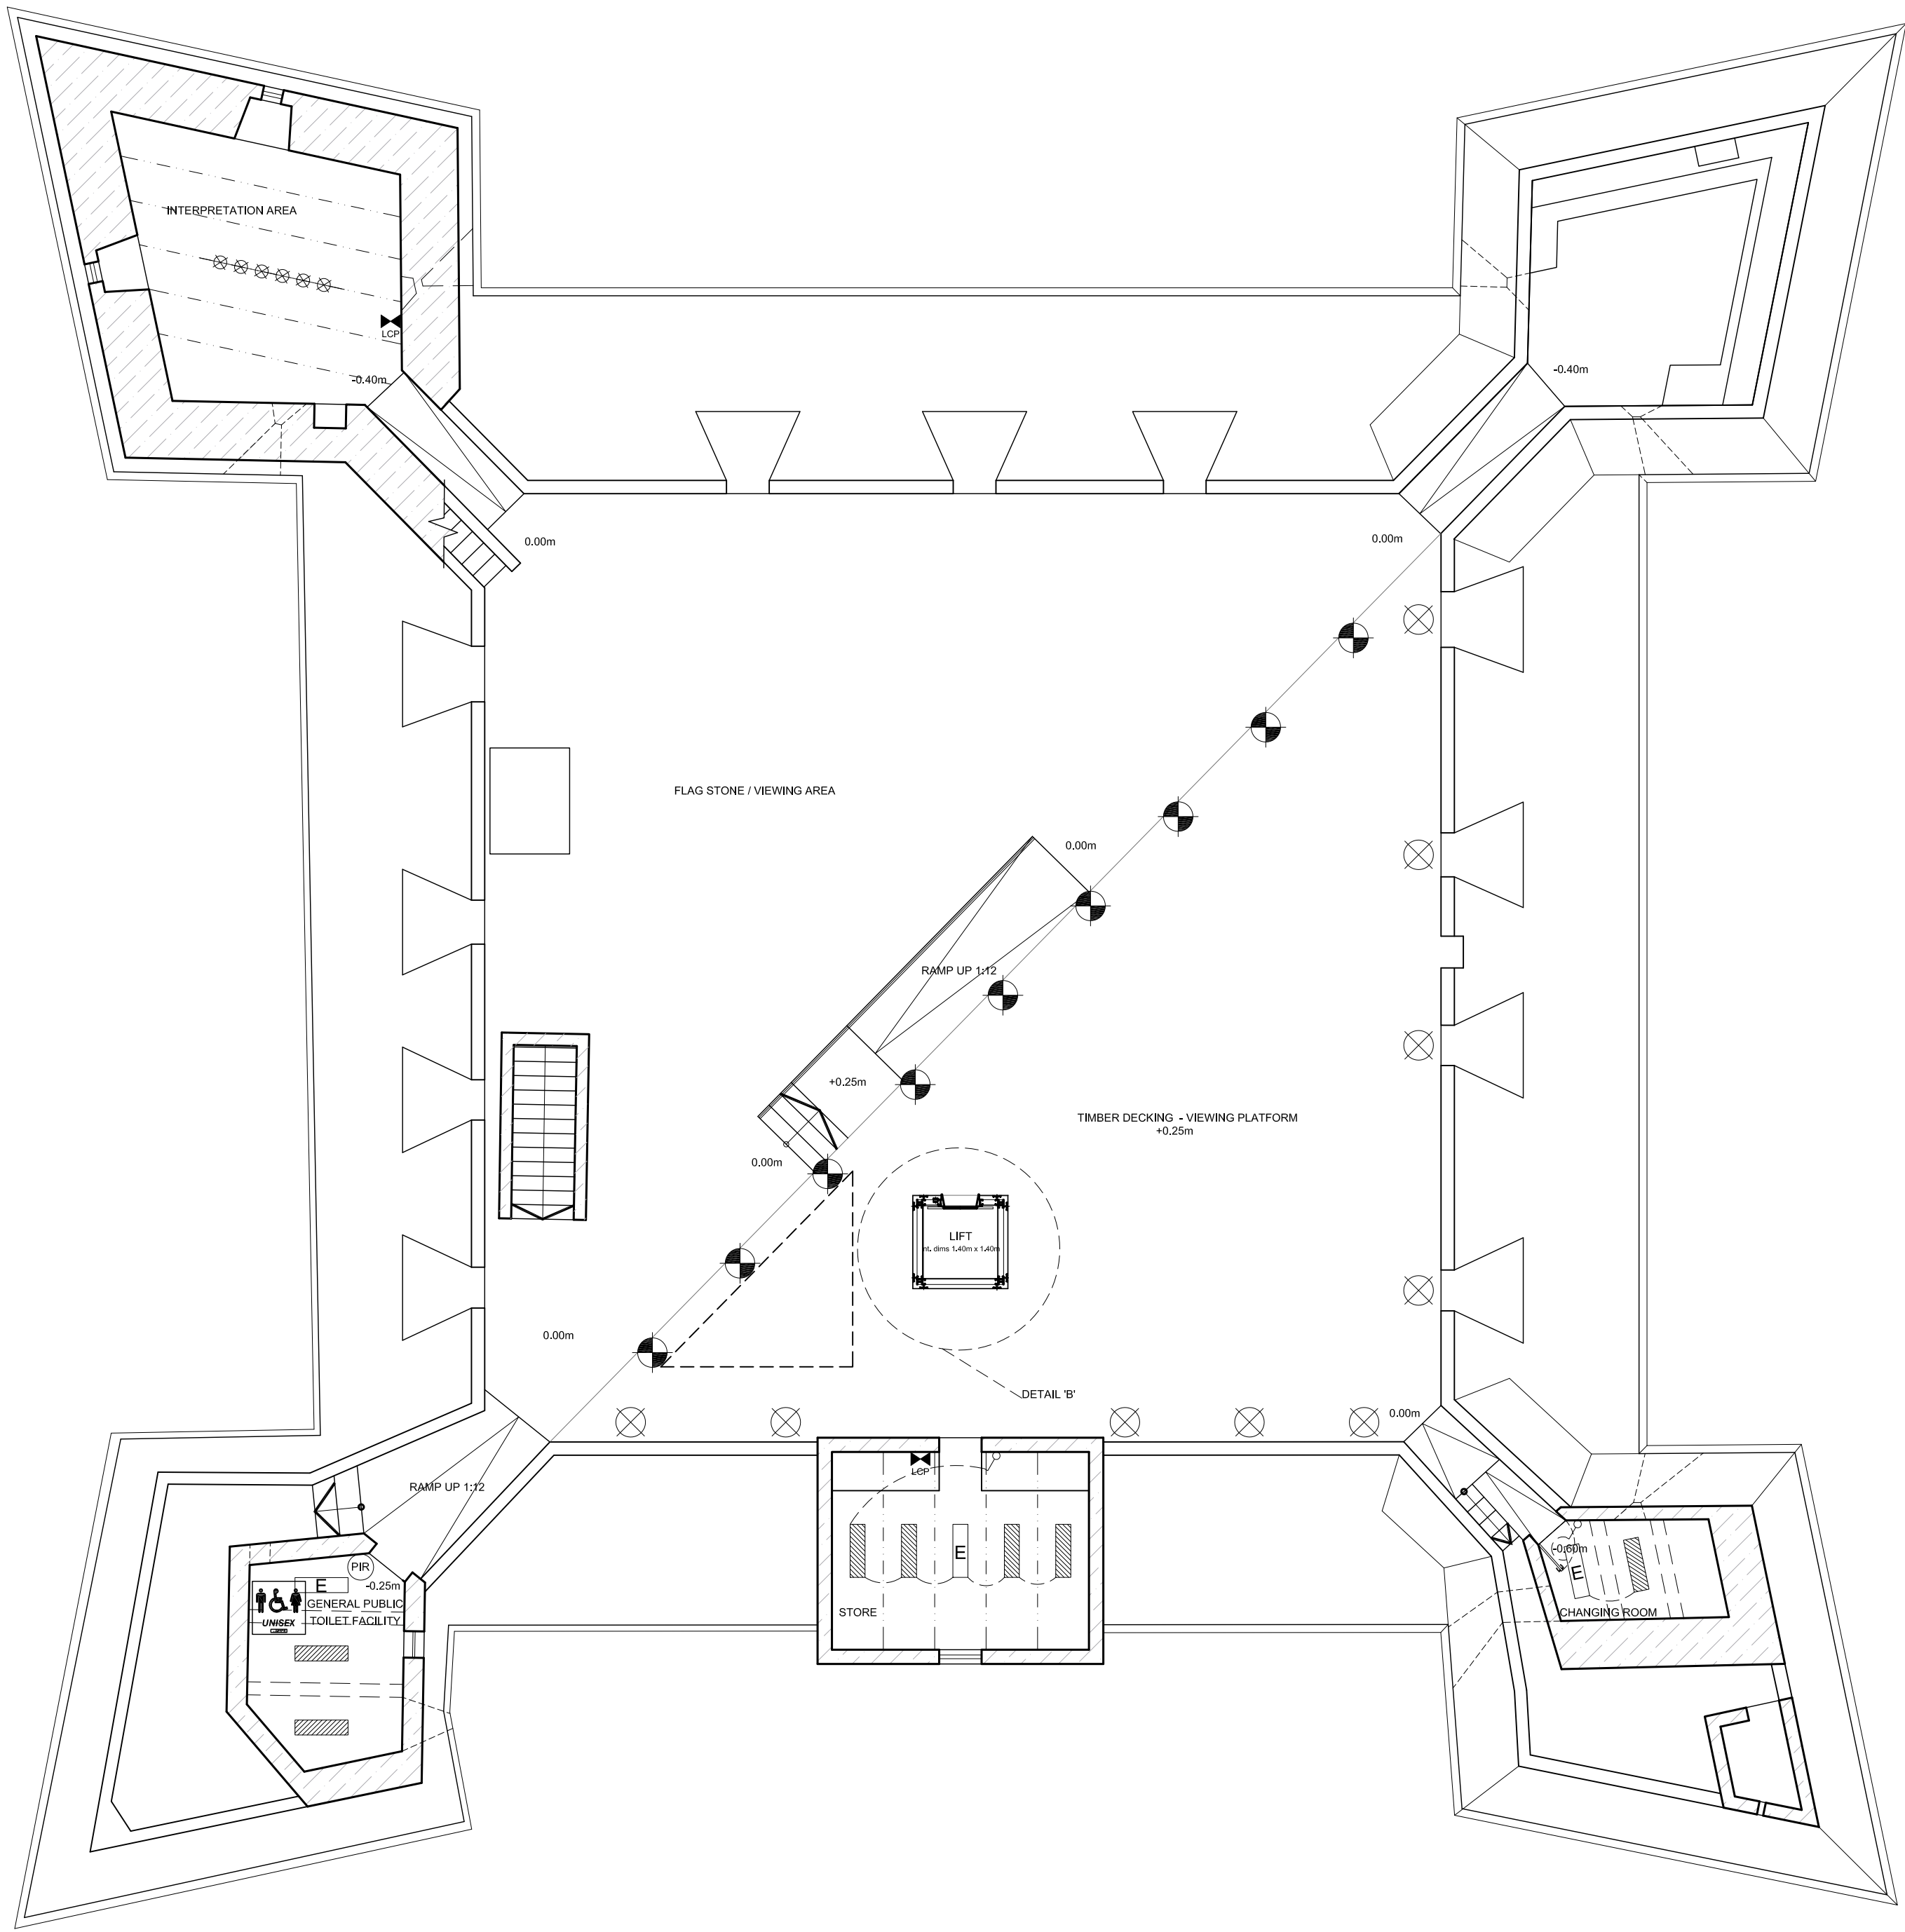


Notes:	
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7	
8	

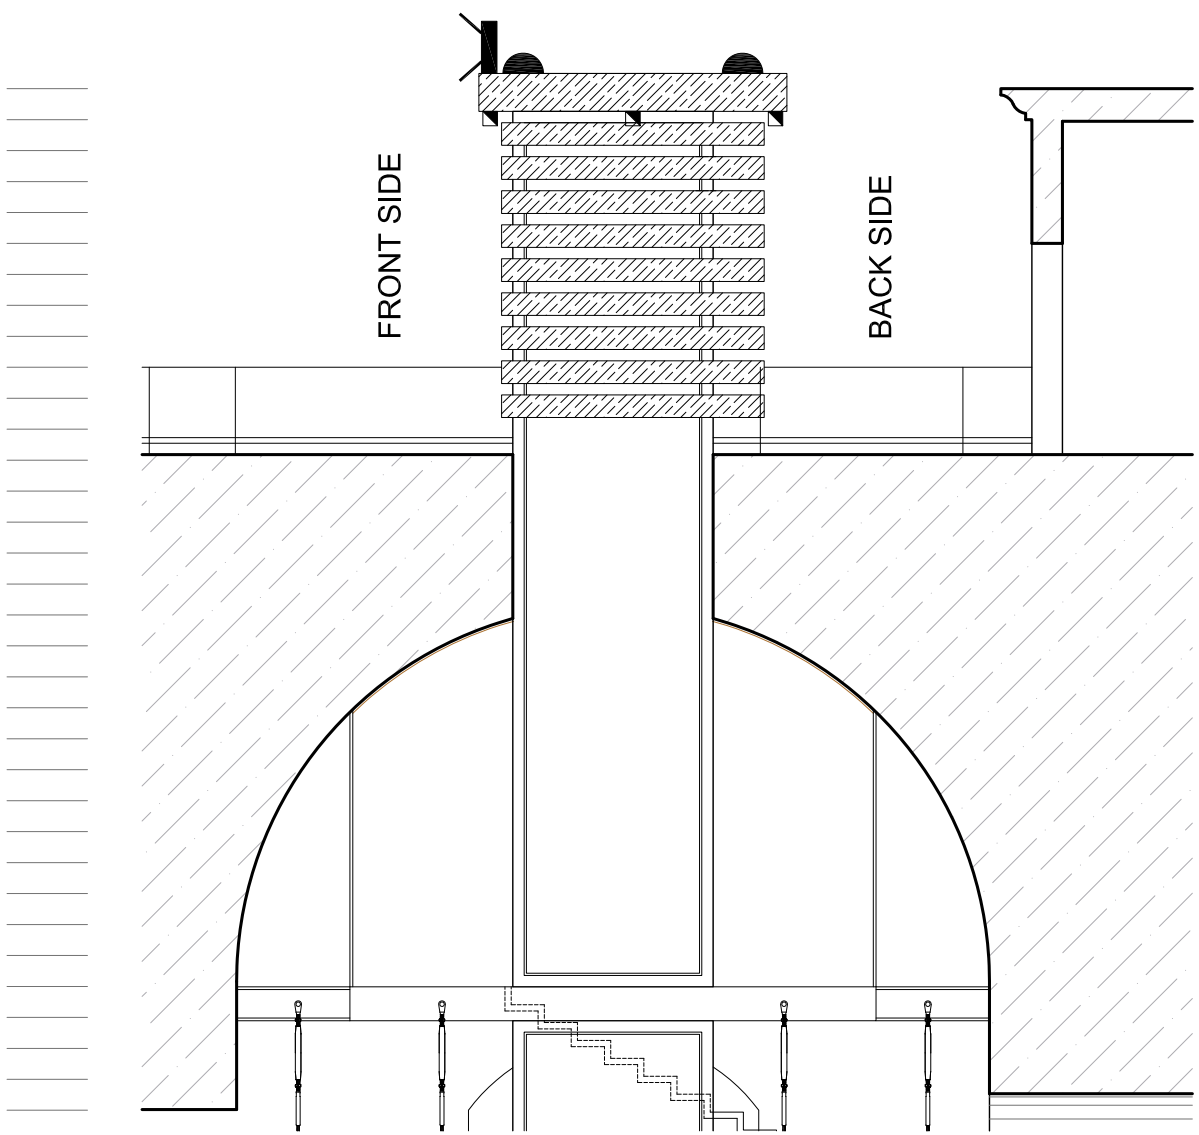

PROPOSED FLOOR PLAN AT LEVEL 3
Scale 1:100

PROPOSED PART PLAN OF CANOPY OVER / AROUND LIFT
N.T.S.

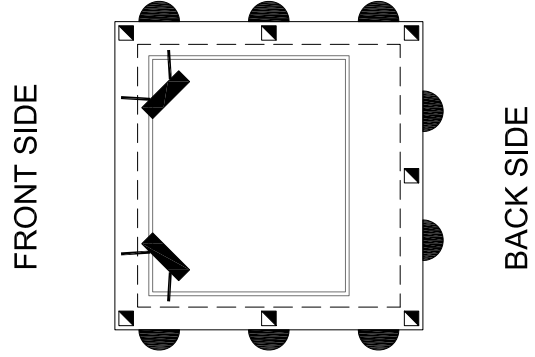



PROPOSED PART SECTION
N.T.S.

LIGHTING LAYOUT LEGEND:

- SINGLE GANG SWITCH
- PASSIVE INFRA-RED DETECTOR
- LIGHTING CONTROL POINT
- LED TRACK LIGHT TYPE 'C'
- LED SPOTLIGHTS ABOVE CANOPY TYPE 'J'
- LED SPOTLIGHTS UNDER CANOPY TYPE 'K'
- BOLLARD ON RAISED FLOORING TYPE 'L'
- SPOT LIGHT IN ROOF DECKING TYPE 'M'
- LED TUBE FITTING TYPE 'N'
- LED EMERGENCY TUBE FITTING TYPE 'O'
- LED FLOOD LIGHT IP66 TYPE 'S'

N.B. - ALL EXTERNAL LUMINAIRES SHOULD BE RATED IP 66
AND THOSE WITHIN REACH SHOULD ALSO BE IK 10 RATED (MAXIMUM VANDAL RATING).

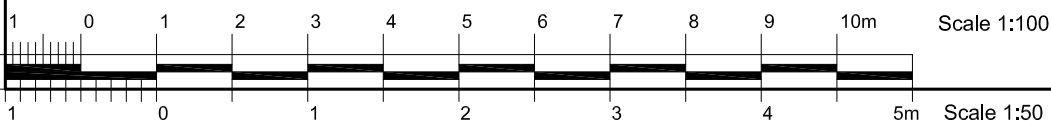



72, BOLOGNA APTS.
TRIQ DUN MICHELE BALZAN,
ATTARD ATD 2980
robert grech
B. E. & A. (HONS.) A. & C. E.
MOB: 79463114 TEL: 21422404

ARCHITECT & CIVIL ENGINEER			
Client: Mr. Mario Farrugia CEO Fondazzjoni Wirt Artna			
Project Title: Rehabilitation and restoration of St Thomas Tower Marsascala, including the creation of a multi-sensory museum, audio-visual rooms, panoramic lift and ditch rehabilitation.			
Drawing Title: PROPOSED FLOOR PLANS AT LEVEL 3 ELECTRICAL LAYOUT			
Client No.: 555	Job No.: 1070	Drawing No.: MSC06-17-lighting	
Checked: RG		To Supersede:	
Scale: 1:100	Date: 27/06/2018	Drawn: JM	Paper Size: A1

Warrant number 1389
Ing. Simon Ellul

