

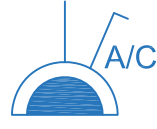







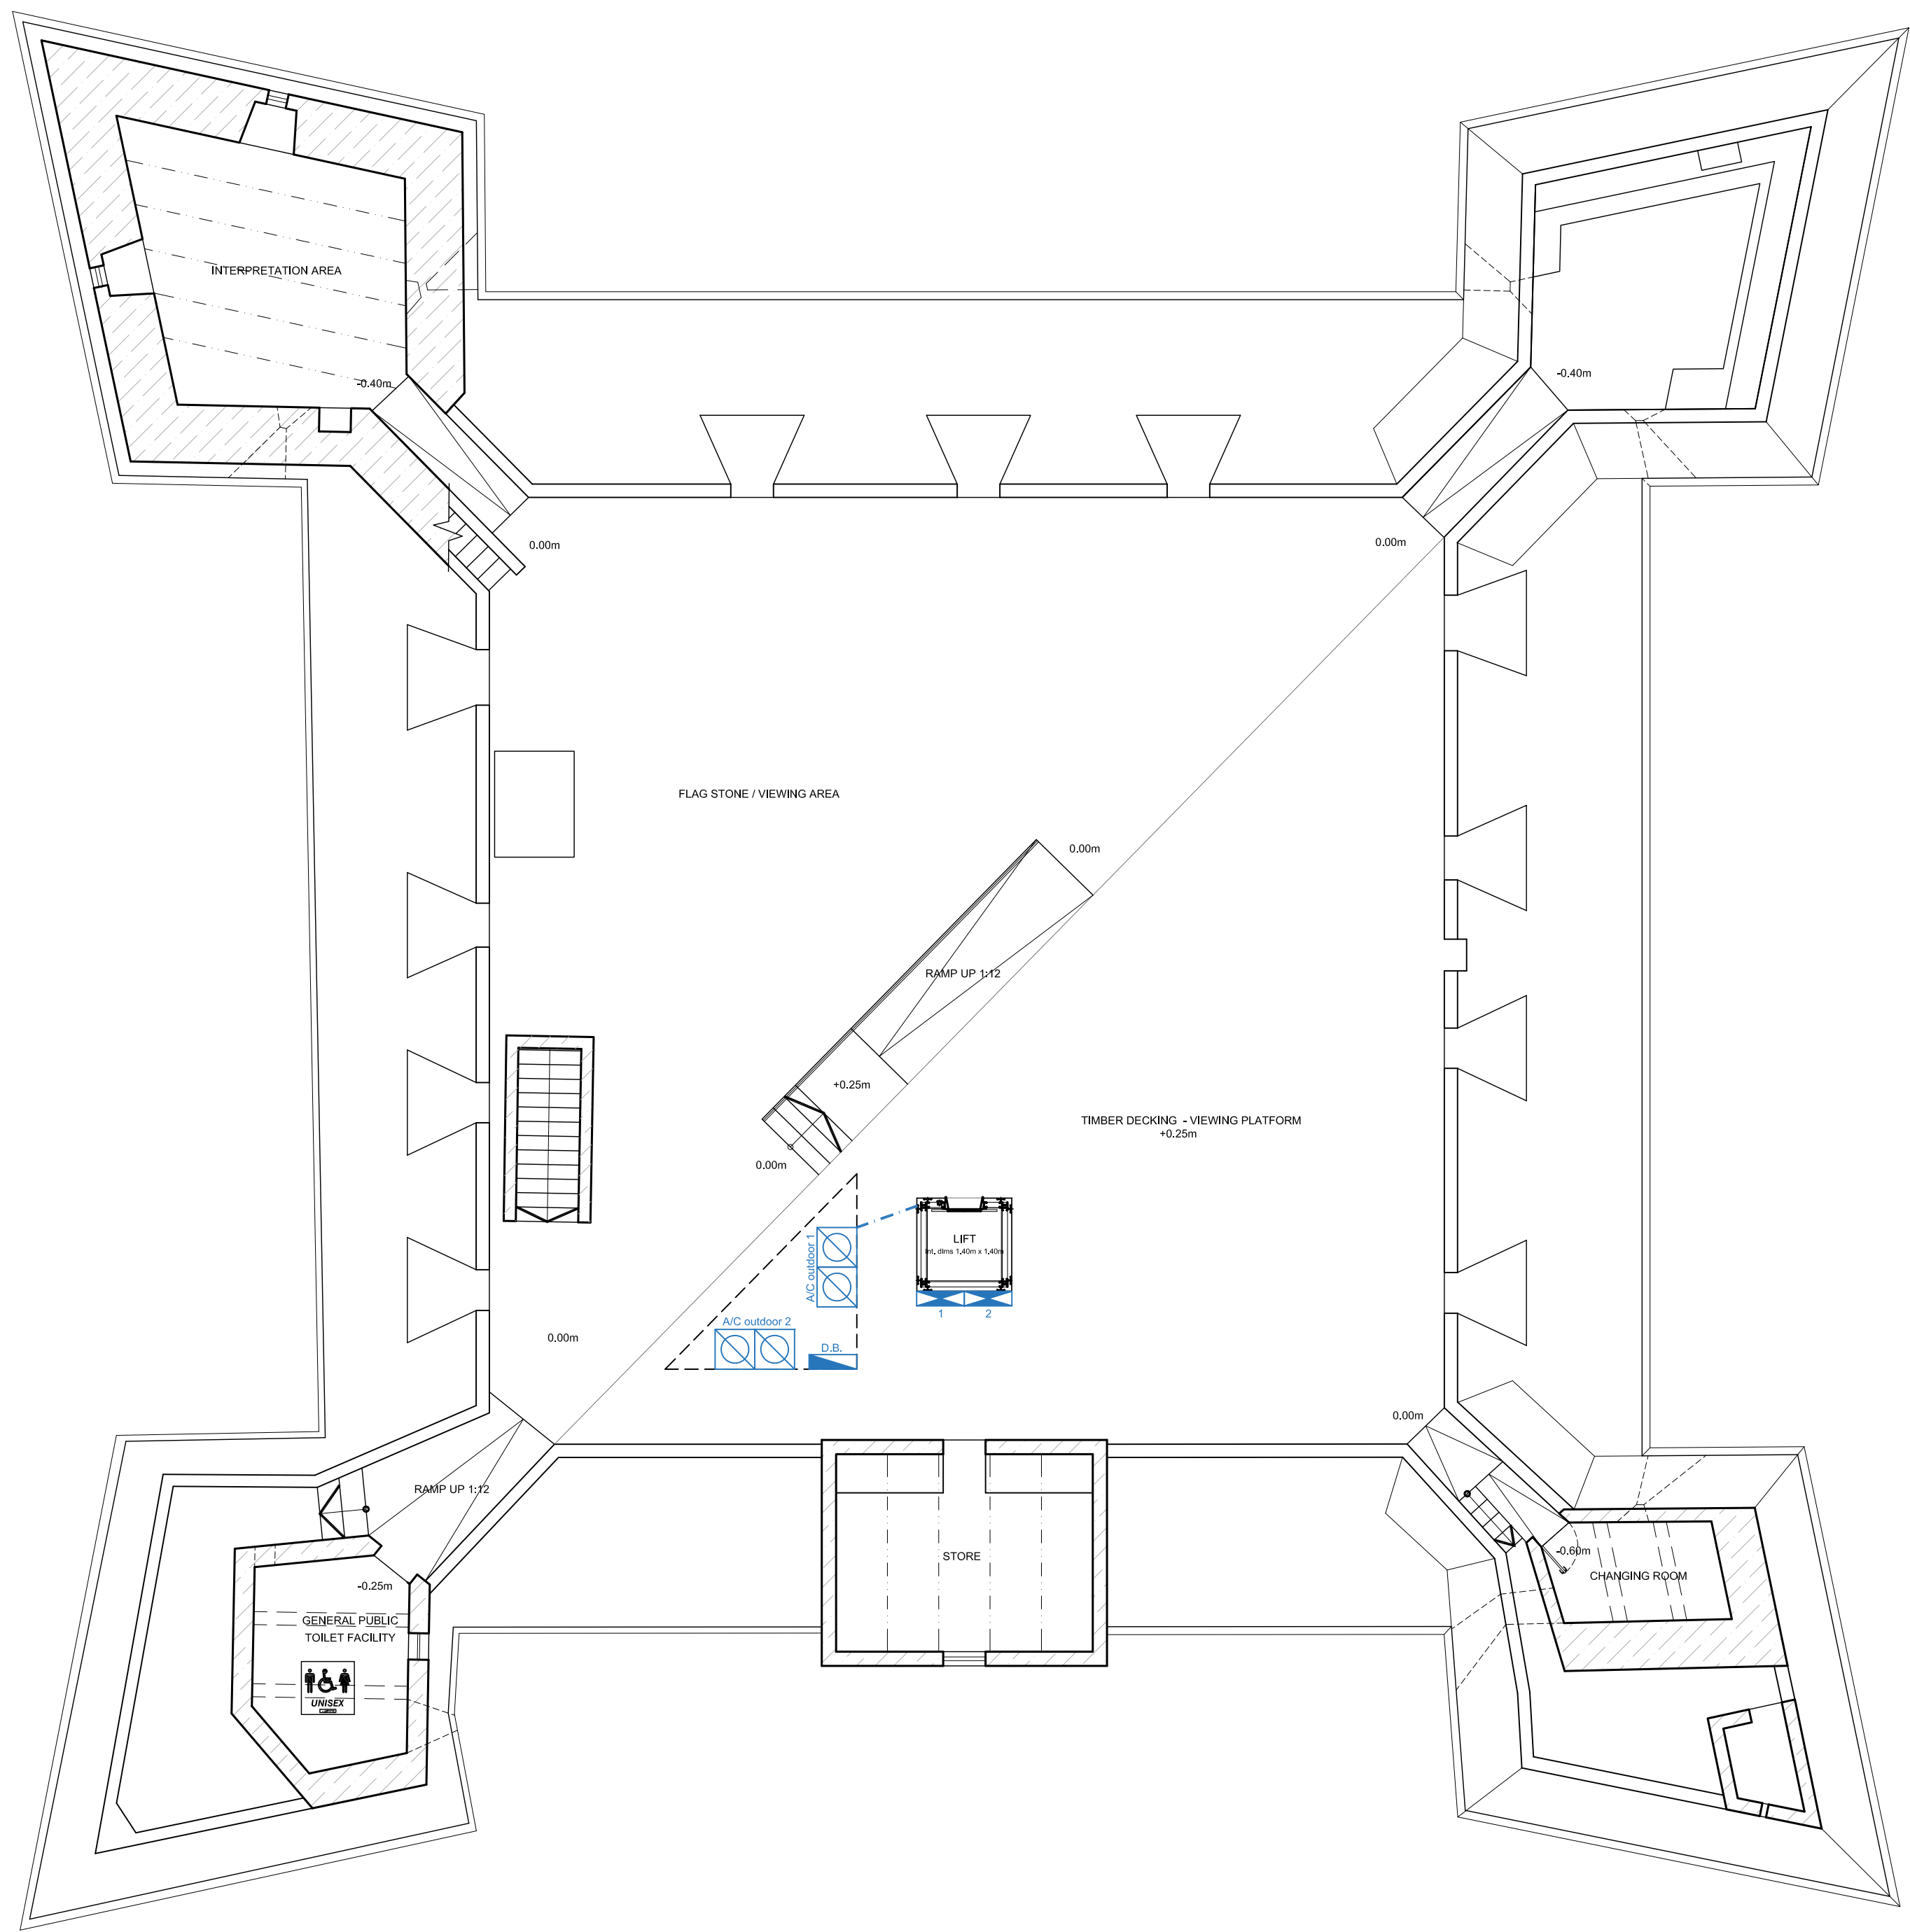

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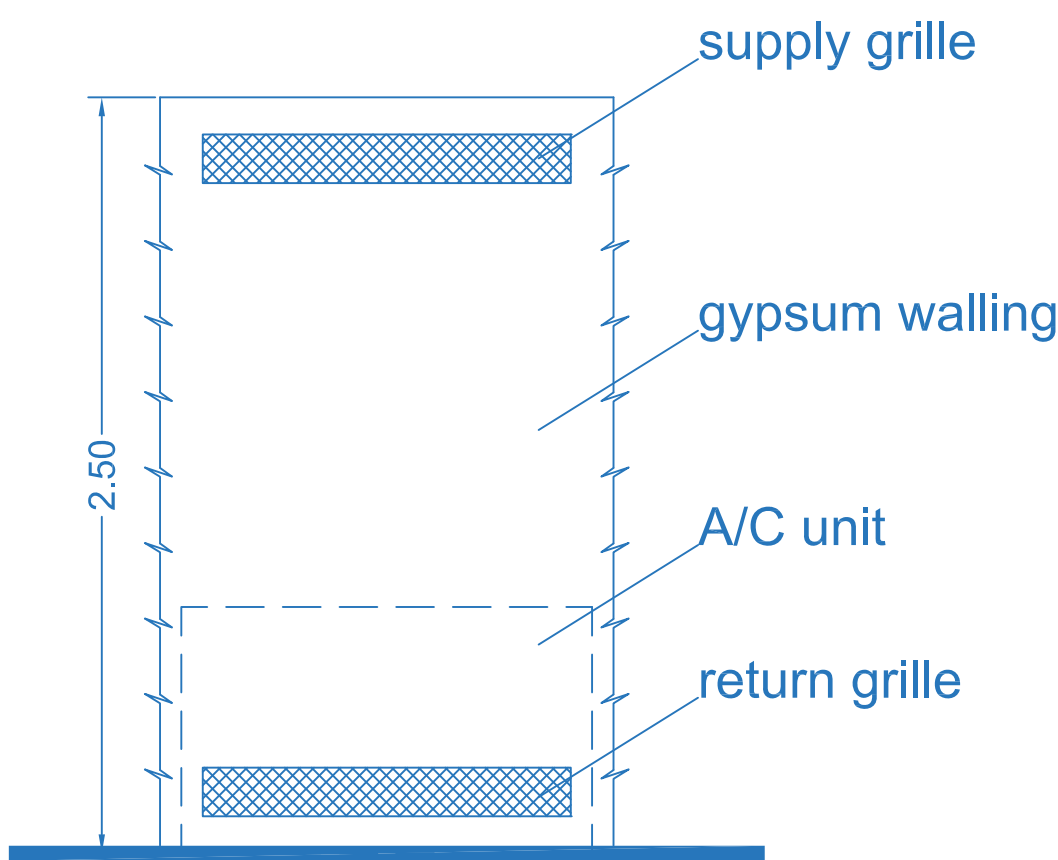


PROPOSED FLOOR PLAN AT LEVEL 3
Scale 1:100


AIR CONDITIONING SYSTEM LAYOUT LEGEND:

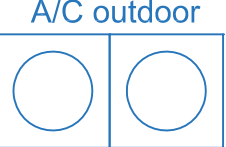-  LOCATION OF AIR CONDITIONING UNITS
-  POWER SUPPLY POINT FOR A/C UNITS WITH 5A DOUBLE POLE SWITCH
-  CABLE TRAY WITH REF A/C PIPEWORK (UNDER RAISED FLOORING)

-  DISTRIBUTION BOARD FOR A/C & VENTILATION
-  A/C OUTDOOR UNIT
-  A/C OUTDOOR UNIT FOR UNITS 1 TO 8 - 60KW
-  A/C OUTDOOR UNIT FOR UNITS 9 & 10 - 20KW
-  ENERGY RECOVERY UNIT (AUDIO VISUAL A)
-  ENERGY RECOVERY UNIT (AUDIO VISUAL B)



TYPICAL GYPSUM WALLING DETAIL

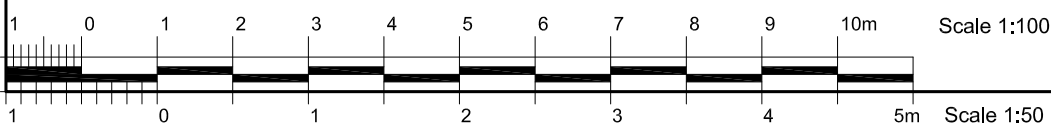

Warrant number 1389
Ing. Simon Ellul

iArchitects

72, BOLOGNA APTS,
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ATTARD ATD 2980
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ARCHITECT & CIVIL ENGINEER

Client: Mr. Mario Farrugia CEO Fondazzjoni Wirt Artna			
Project Title: Rehabilitation and restoration of St Thomas Tower Marsascala, including the creation of a multi-sensory museum, audio-visual rooms, panoramic lift and ditch rehabilitation.			
Drawing Title: PROPOSED FLOOR PLANS AT LEVEL 3 AIR CONDITIONING LAYOUT			
Client No.: 555	Job No.: 1070	Drawing No.: MSC06-09-ac. vent.	
Checked: RG		To Supersede:	
Scale: 1:100	Date: 27/06/2018	Drawn: JM	Paper Size: A1